


NOTE: PLAN SHOWS EXTERIOR WALL TYPE ALTERNATE 2B. INSERTS AT CORNERS, OPENINGS, ETC. SHOW BASE PROPOSAL CONSTRUCTION (SEE ALSO EXTERIOR WALL TYPES, SHEET NO. 17). NORMAL RUNNING BOND HORIZONTAL BLOCK COUSING AT EXTERIOR WALLS FOR BASE PROPOSAL AND ALTERNATE 2A SHALL BE "STRETCHED" TO CORRESPOND TO OVERALL PANEL AND OPENING LAYOUT.

NOTE: FOR IDENTIFICATION OF EQUIPMENT ITEMS INDICATED AS (M) REFER TO EQUIPMENT SCHEDULE ON SHEET NO. 4.

NOTE: PRECAST CONCRETE WALL PANELS ARE DIMENSIONED AS FOLLOWS:
 1. TO FACE OF JOINT IN TYPICAL RUNS.
 2. TO ACTUAL END OF PANEL AT OPENS.
 3. TO ACTUAL FACE OF PANEL AT GRIDS.
 4. ASSUME "TRACON" STANDARDS: 1/8" JOINT ± TO ± WITH 1/4" JOINT ± 1/2" TOLERANCE @ EXTERIOR WALL. OTHER MANUFACTURERS' STANDARDS SUBJECT TO REVIEW FOR CONFORMANCE TO DETAILS.

NOTE: CONCRETE BLOCK IS DIMENSIONED AS FOLLOWS:
 1. NOMINAL THICKNESS

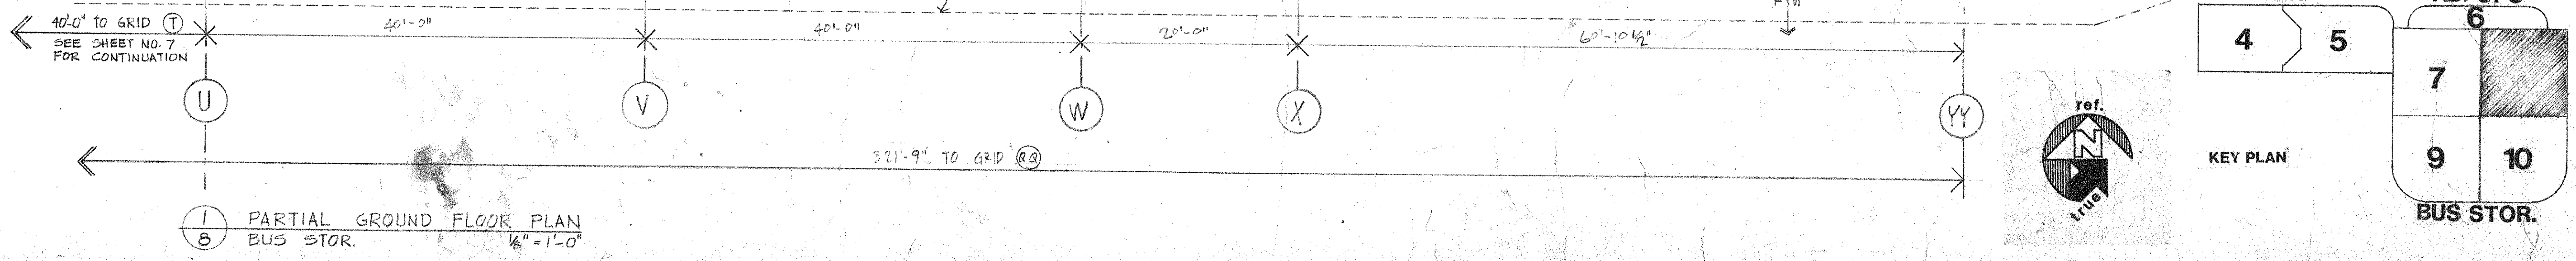

1 PARTIAL GROUND FLOOR PLAN
 8 BUS STOR. 1/8" = 1'-0"

John Veitch/Thomas A. Vecchi, Inc. 1518 East Superior Street, Duluth, Minnesota 55812 (218) 724-8802

PARTIAL GROUND FLOOR PLAN - BUS STORAGE

DTA OPERATING CENTER
 PHASE 3 CONSTRUCTION
 PROJECT NO. MN-03-0018
 DULUTH MINNESOTA